## **OSTIUM VESTIBULES - TYPE 1**

PRE-ENGINEERED ARCHITECTURAL SYSTEMS

ARCHITECT:


ARCH. NAME


ARCH. ADDRESS 1 ARCH. ADDRESS 2 ARCH. CONTACT # GLASS + METAL CRAFT

48230 WEST ROAD WIXOM, MI 48393 P. 248.624.5050 F. 248.624.6988



				CRAFT
GLAZING SCHEDULE	SYSTEM NOTES	<b>DESIGN CRITERIA</b>	SUBMITTAL LOG	PROPRIETARY NOTICE: THIS DRAWING SHEET AND CONTENTS HEREIN ARE PROPERTY OF GLASS AND METAL CRAFT AND ITS CUSTOMERS. USE OF THESE DRAWINGS
TYPE: GL-1 GL-1   13/16" LAMINATED GLASS  SURFACE   MAKEUP: /_" TEMPERED GLASS 0.060" CLEAR SQP INTERLAYER /_" TEMPERED GLASS NOTES:			1 PROPOSAL / PROGRESS REVIEW SUBMITTAL XX.XX.XX AL 2 3	ITS CONTENT AND DESIGN CONCEPTS ARE INTENDED FOR THE USE OF THE INTENDED RECIPIENT. GLASS AND METAL CRAFT AND ITS CUSTOMERS ARE NOT RESPONSIBLE FOR USE B' OTHER PARTIES.
EXTERIOR  EXPOSED EDGES TO BE FLAT POLISHED  LAMINATED LOGO: NO LOGO:  *TEMPERING LOGO AVAILABLE UPON REQUEST			4 5 6	
				_
				SUBMITTED FOR PRELIMINARY REVIEW. FOR
METAL FINISH			SHEET INDEX	DESIGN REPRESENTATION ONLY. THIS SUBMITTAL HAS NOT BEEN ENGINEERED TO ACCOMMODATE SITE-SPECIFIC CONDITIONS
			C1         COVER SHEET           P1         PLAN VIEWS           E1         ELEVATIONS           D1 THRU D4         DETAILS	FOR THIS SYSTEM.  REVISION DATE SI XX.XX.XX 1
				2 - 3 - 4 - DRAWN BY: DATE:
			ABBREVIATIONS	AL XX.XX.XX  ARCHITECT: ARCHITECTURE FIRM NAME  GMC SYSTEM TYPE:
			GLASS   GLASS ORIENTATION (E1-1A) GLASS TAG  WORKPOINT (GL-1) GLASS GL TYPE  F.O FINISH OPENING W.P WORK POINT	OSTIUM VESTIBULES - TYPE PROJECT NAME: PROJECT NAME
			R.O ROUGH OPENING F.F FINISH FLOOR  C.O CLEAR OPENING V.I.F VERIFY IN FIELD  D.O DOOR OPENING O.H OPPOSITE HAND	SHEET DESCRIPTION:  COVER SHEET
			G.S GLASS SIZE SIM SIMILAR  D.S DOOR SIZE EQ EQUAL	SHEET:
4			E.O.G EDGE OF GLASS Ç - CENTERLINE	

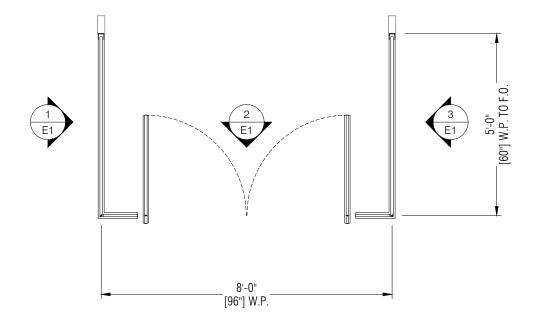

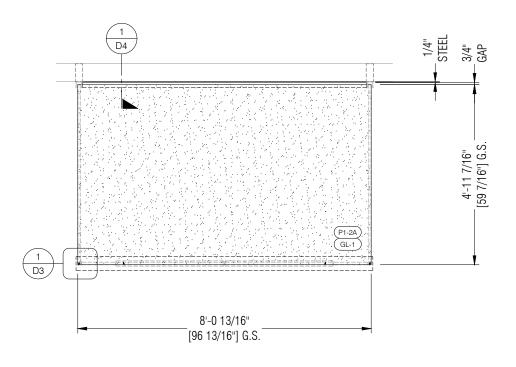



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REVISION SI 1 2 3 4	DATE XX.XX.XX - -	
DRAWN BY: AL	DATE: XX.XX.XX	

ARCHITECT:

ARCHITECTURE FIRM NAME

GMC SYSTEM TYPE:

OSTIUM VESTIBULES - TYPE

PROJECT NAME:

PROJECT NAME

SHEET DESCRIPTION:

**PLANS** 

SHEET:


VESTIBULE 1 FLOOR PLAN P1 DRAWING SCALE:

24x36: 3/4" = 1'-0" 11x17: 3/8" = 1'-0"


P1

**VESTIBULE 1 ROOF PLAN** 


DRAWING SCALE: 24x36: 3/4" = 1'-0" 11x17: 3/8" = 1'-0"

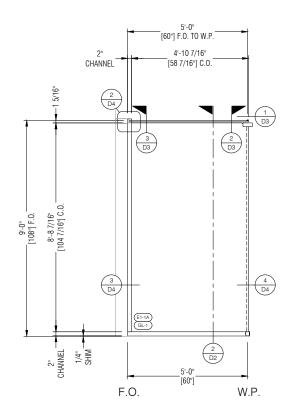

**ELEVATION AT RETURN** DRAWING SCALE: 24x36: 1/2" = 1'-0" 11x17: 1/4" = 1'-0" E1

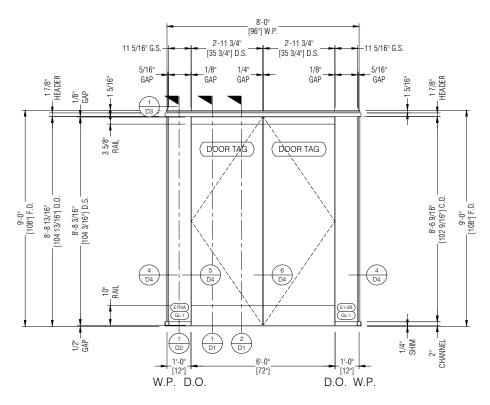

**ELEVATION AT VESTIBULE 1** DRAWING SCALE: 24x36: 1/2" = 1'-0" 11x17: 1/4" = 1'-0" E1

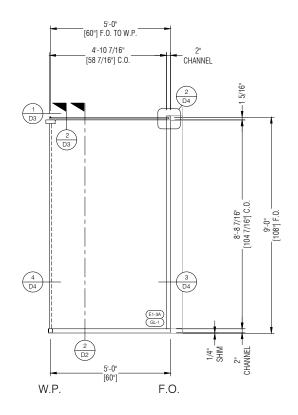

**ELEVATION AT RETURN** DRAWING SCALE: 24x36: 1/2" = 1'-0" 11x17: 1/4" = 1'-0" E1



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OSTIUM VESTIBULES - TYPE


PROJECT NAME:

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SHEET DESCRIPTION:

**ELEVATIONS** 

SHEET:



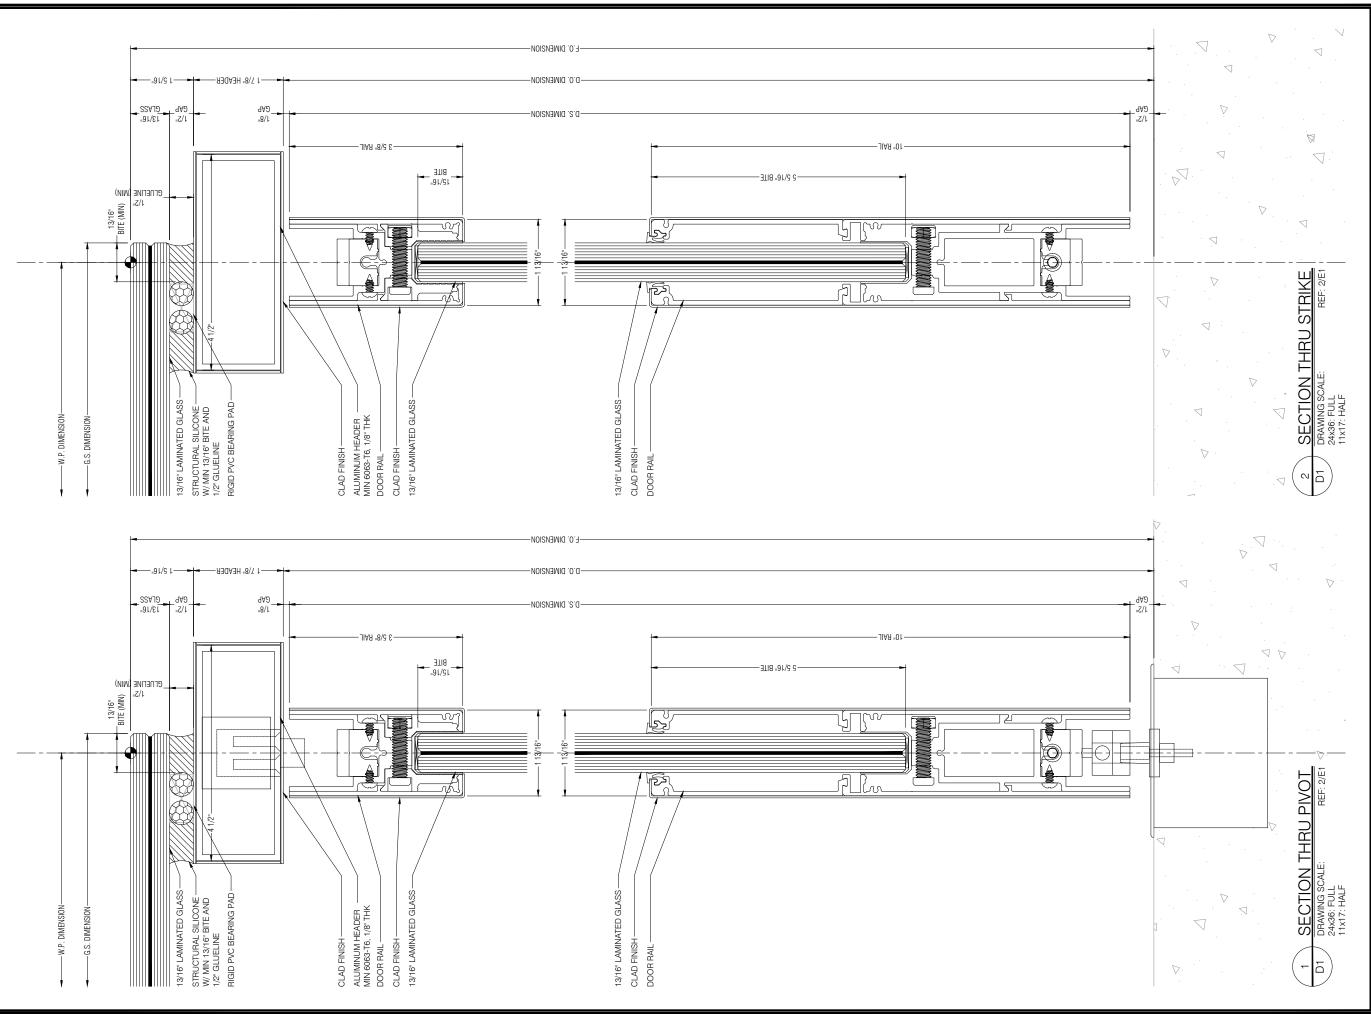

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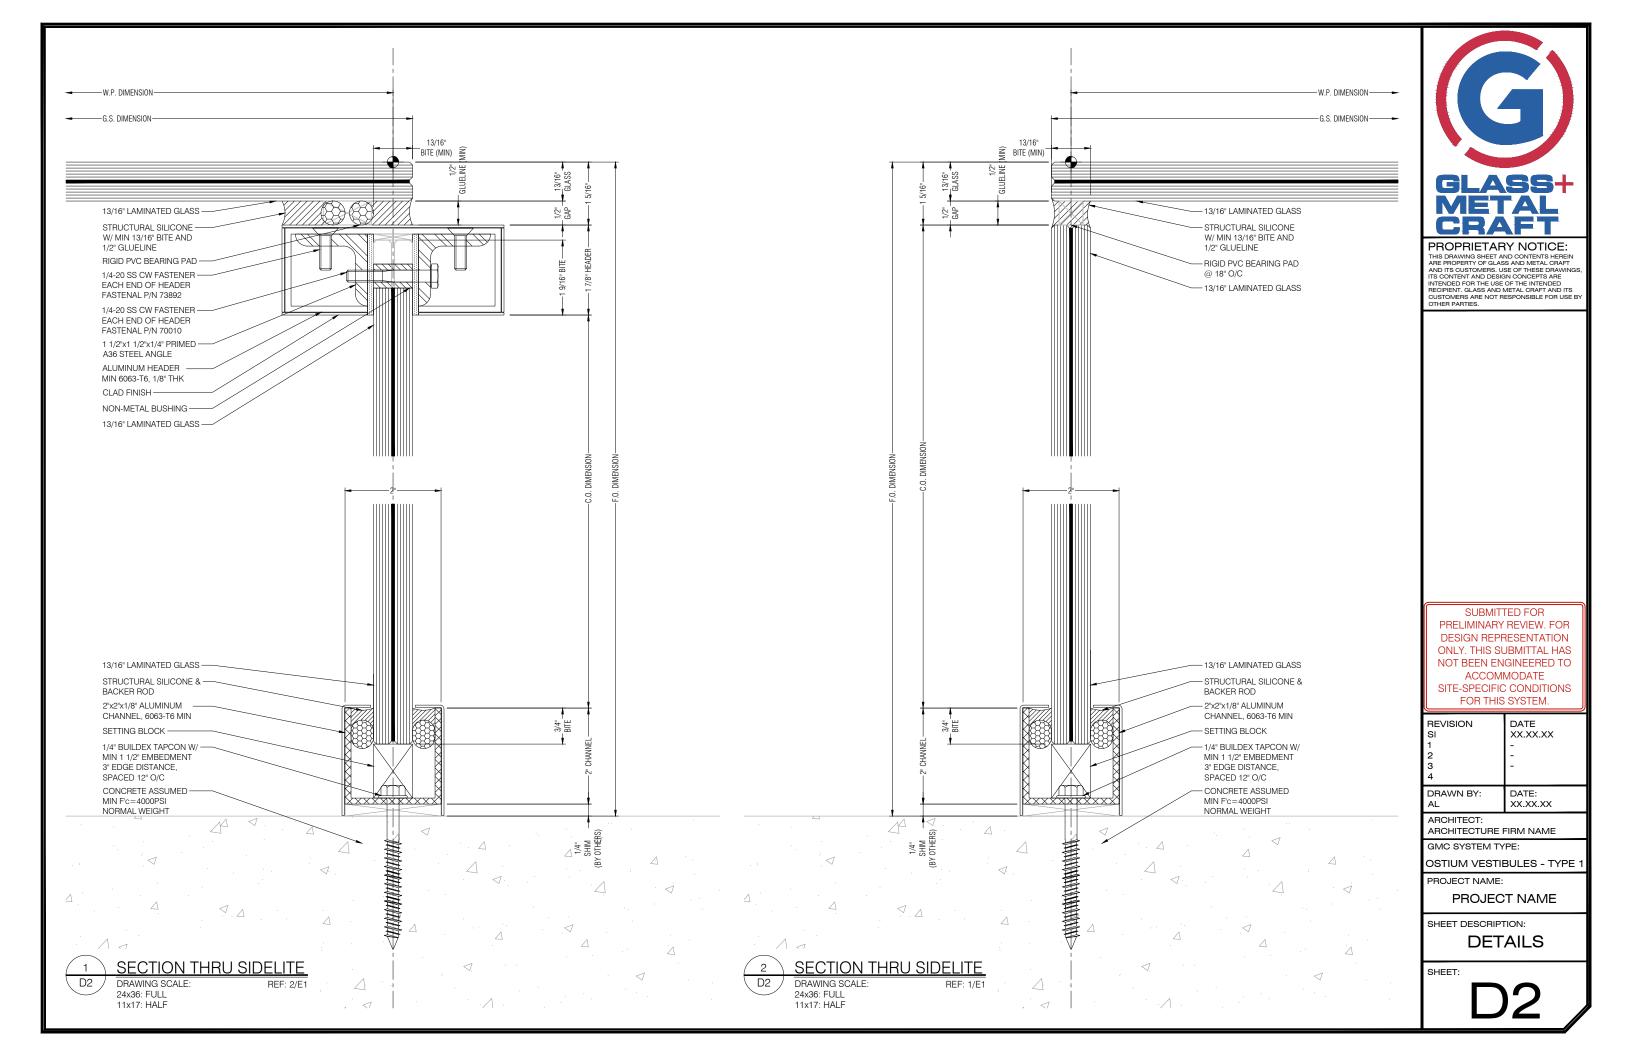
PROJECT NAME:


PROJECT NAME

SHEET DESCRIPTION:

**DETAILS** 

SHEET:



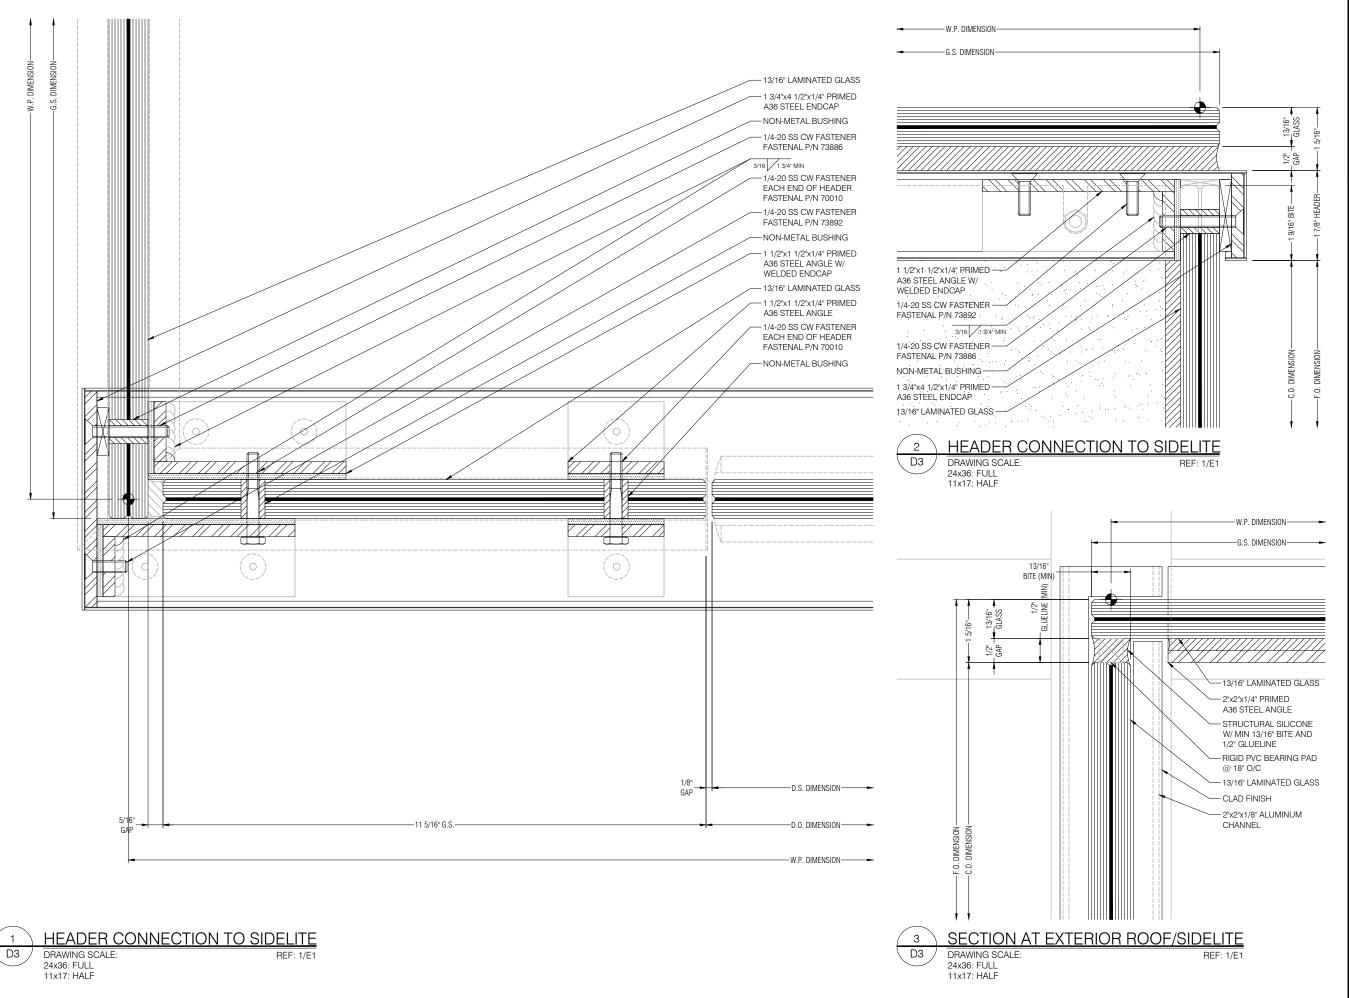

GLASS+ METAL CRAFT

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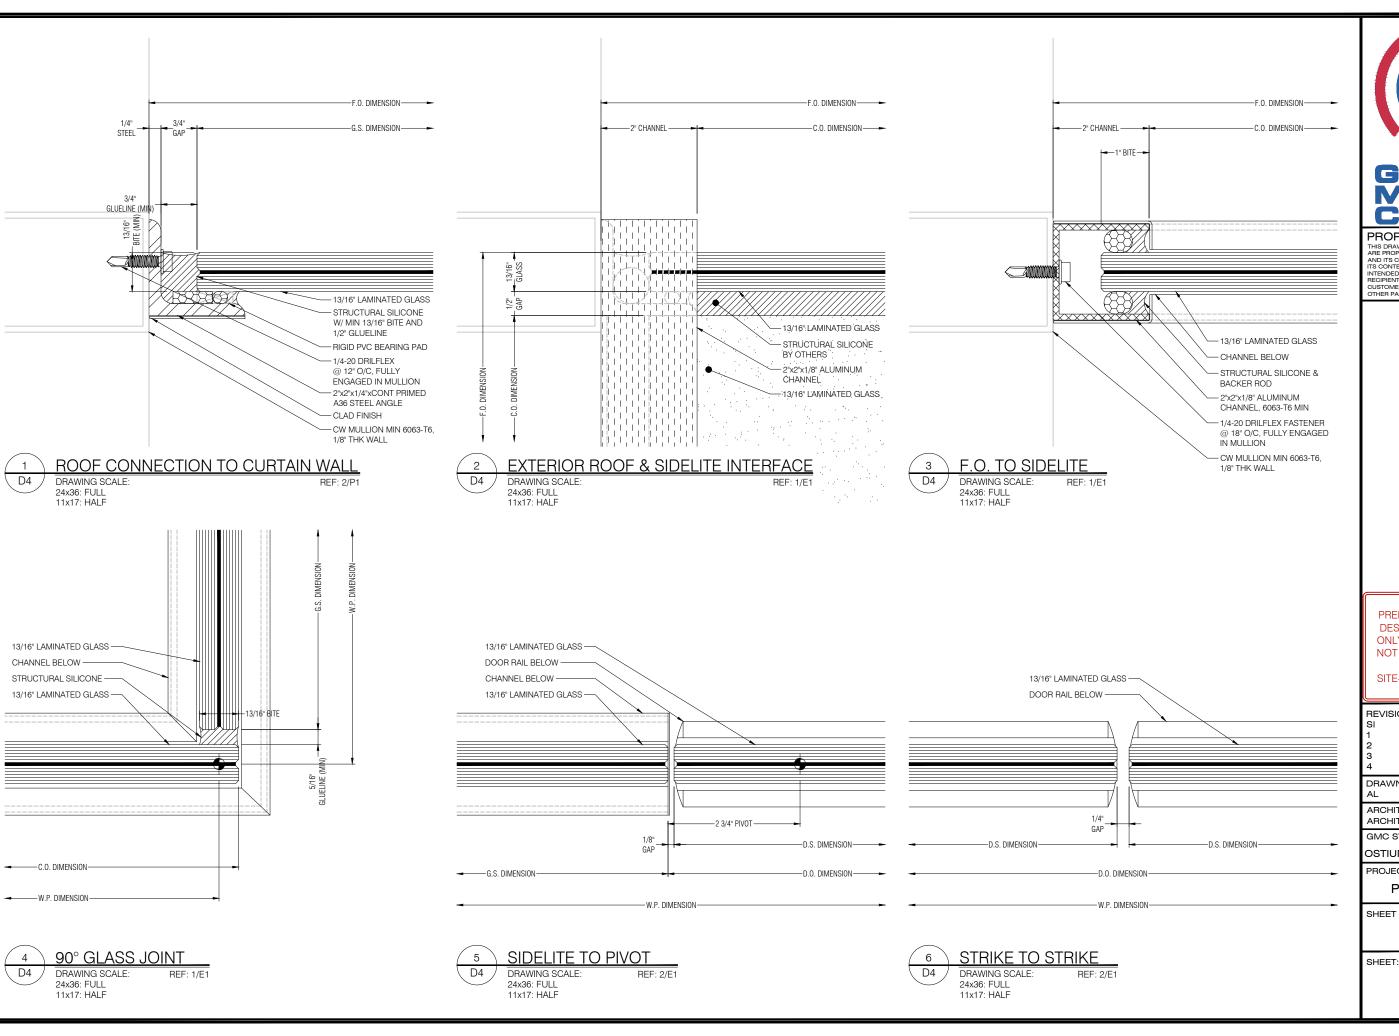
PROJECT NAME

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SHEET:

D3



**GLASS+** 

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**DETAILS**